

# WASHINGTON DEPARTMENT OF FISH AND WILDLIFE SCATTER CREEK WLA - BLACK RIVER UNIT MIMA ACCESS & PARKING TN:R109:2023-1

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# **ABBREVIATIONS**

AVENUE AVE CORRUGATED METAL PIPE CRUSHED SURFACE TOP COURSE DIAMETER FEET GAUGE GALVANIZED HOT MIX ASPHALT HOLLOW STRUCTURAL SECTION HIGHWAY LINEAL FEET MILE(S) MINIMUM OUTSIDE DIAMETER PARKER KRYLON SOUTH SCHEDULE SQUARE SOUTHWEST TYPICAL

# SHEET SYMBOLS

SHEET CALLED FROM SHEET LOCATED ON

<u>DETAIL</u>

SHEET CALLED FROM SHEET LOCATED ON

**SECTION** 


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NOTE REFERENCE
REFERENCE DESIGNATION TO A
NOTE, A PART, OR MATERIAL IN A

SCHEDULE/TABLE

PROJECT NO.
TN:R109:2023-1

SHEET OF 8

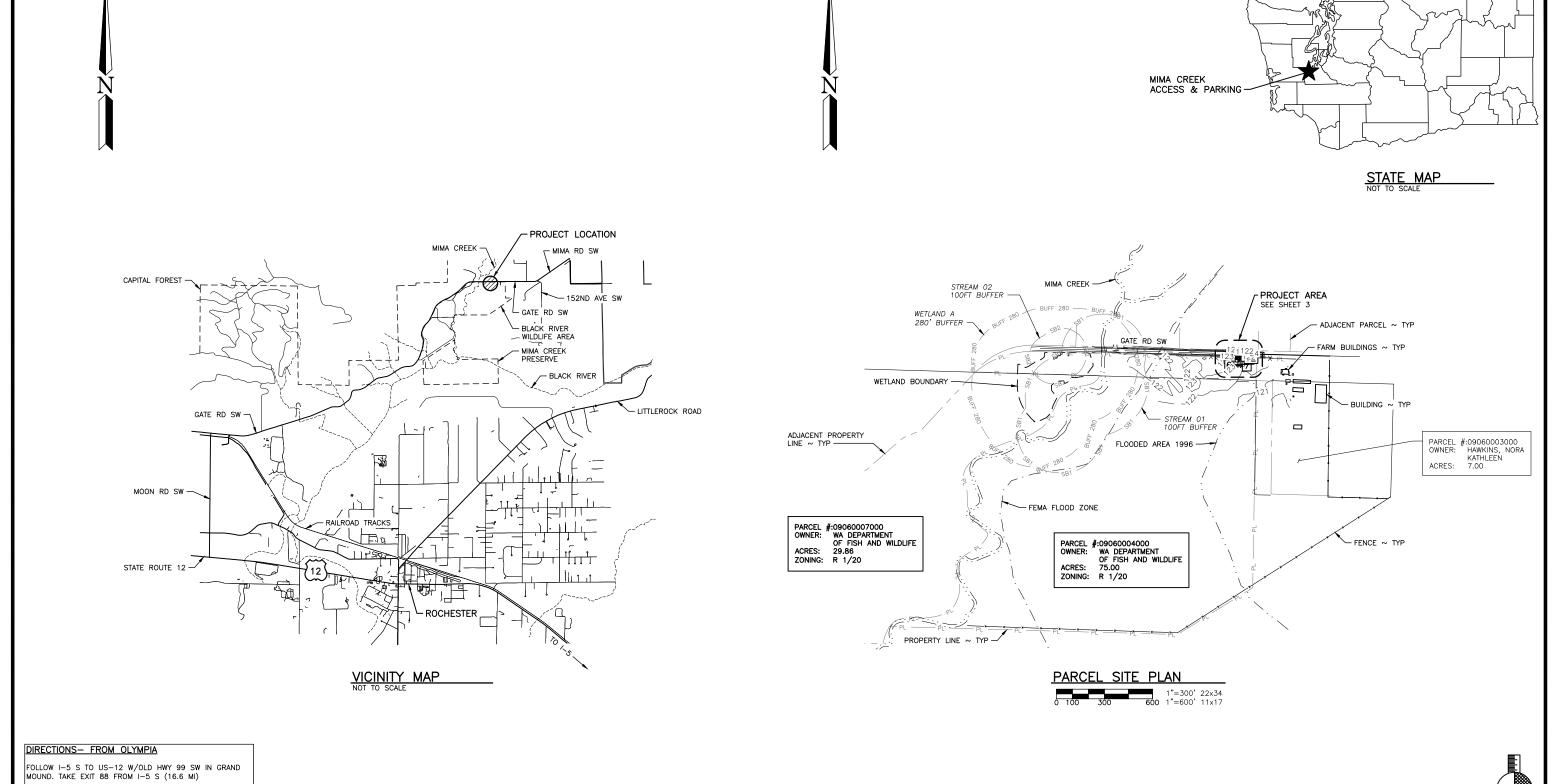

TURN RIGHT ONTO US-12 W/OLD HWY 99 SW (0.4 MI)

TURN RIGHT ONTO MOON RD SW (1.2 MI)

TURN RIGHT ONTO GATE RD SW/MIMA GATE RD SW CONTINUE TO FOLLOW GATE RD SW (3.7 MI)

SYM DATE REVISION DESCRIPTION APPROVED AND RELEASED FOR CONSTRUCTION PROGRAM

SCATTER CREEK WLA - BLACK RIVER UNIT
MIMA ACCESS & PARKING
VICINITY MAP & PARCEL SITE PLAN

DESIGNED BY R. BEESLEY

CHECKED BY S. GOODWIN

DRAWN BY R. SANTIAGO DATE 8/30/2024

. DATE: .


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PROJECT NO. TN:R109:2023-1 SHEET OF

8

FISH & WILDLIFE

WASHINGTON DEPARTMENT OF

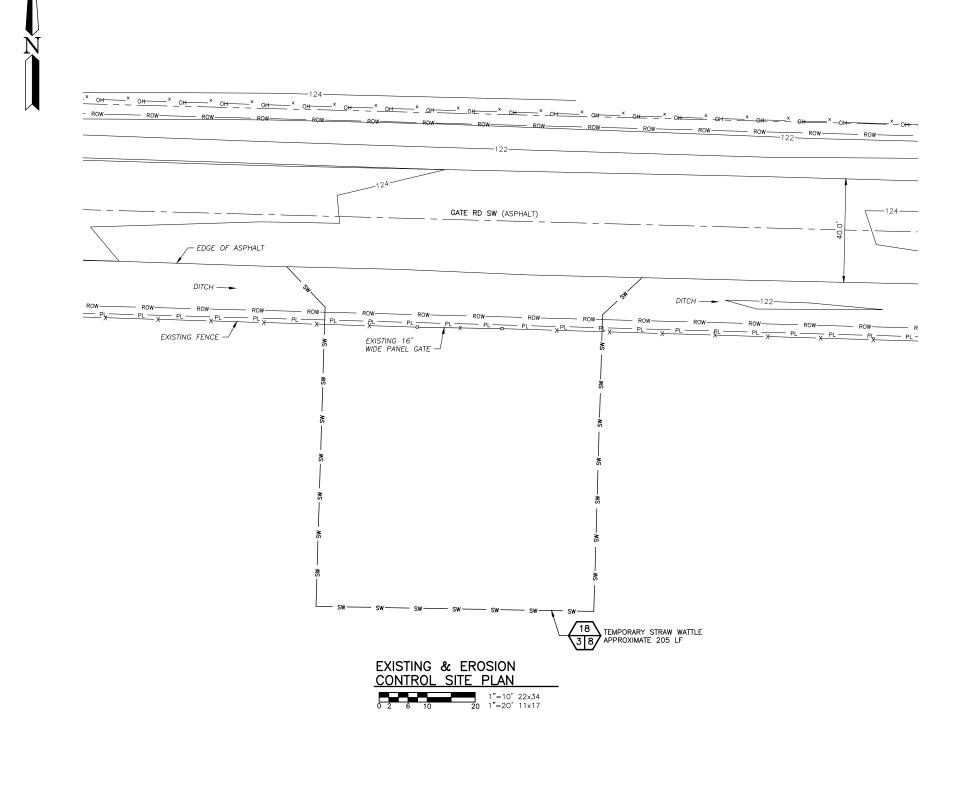

REVISION DESCRIPTION

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SCATTER CREEK WLA - BLACK RIVER UNIT

MIMA ACCESS & PARKING

EXISTING & EROSION CONTRIL SITE PLAN

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SHEET


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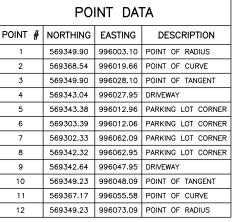
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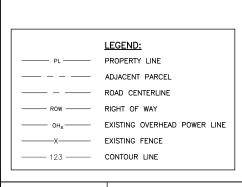
CONTOUR LINE

WASHINGTON DEPARTMENT OF

FISH & WILDLIFE





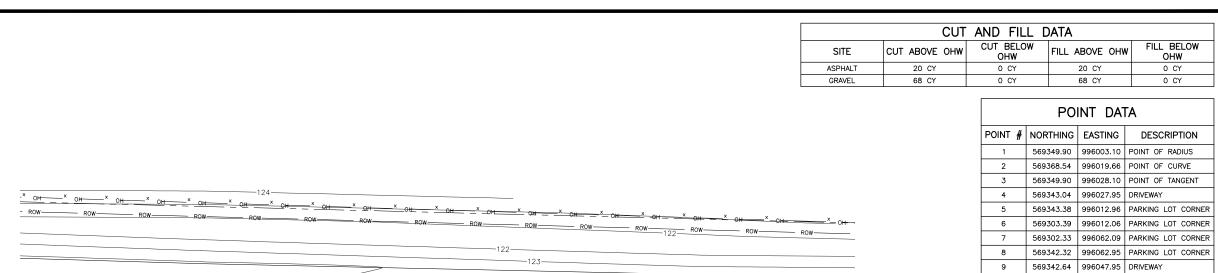

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SYM DATE REVISION DESCRIPTION DESIGNED BY R. BEESLEY APPROVED AND RELEASED FOR CONSTRUCTION CHECKED BY S. GOODWIN DRAWN BY R. SANTIAGO DATE 8/30/2024

GATE RD SW (ASPHALT)

LINE FENCE
APPROXIMATE 140 LF

GRAVEL PARKING AREA (2,001 SQ FT)

NEW SITE PLAN

ASPHALT DRIVEWAY PER THURSTON COUNTY TYPE B DRIVEWAY ACCESS (591 SQ FT)

16 12" HDPE DOUBLE WALL CULVERT

2-7

- EDGE OF ASPHALT

EXISTING FENCE -

INITIAL 50'x80' PROPOSED PARKING AREA (3,813 SQ FT) -


SCATTER CREEK WLA - BLACK RIVER UNIT MIMA ACCESS & PARKING NEW SITE PLAN

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FISH & WILDLIFE


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# LINE FENCE NOT TO SCALE 1

### NOTES:


- 1. ALL T-POSTS SHALL NOT EXCEED 12 FEET OF SPACING.
- STEEL T-POSTS SHALL BE HEAVY DUTY WEIGHT (1.33#), CERTIFIED ASTM-A702, GREEN WITH WHITE TOP, AND MINIMUM OF 6 FEET IN LENGTH. ALL POSTS SHALL BE DRIVEN TO A MINIMUM DEPTH OF 18 INCHES. IF THE T-POST DESIGN DEPTH CANNOT BE OBTAINED BY CONVENTIONAL DRIVING DUE TO EXISTING SOIL/ROCK CONDITIONS, THE POST HOLE SHALL BE DRILLED. SEE DRILLED T-POST INSTALLATION.
- 3. WIRE CLAMPS TO ATTACH BARB WIRE TO STEEL POSTS SHALL BE 11 GA GALVANIZED WIRE.

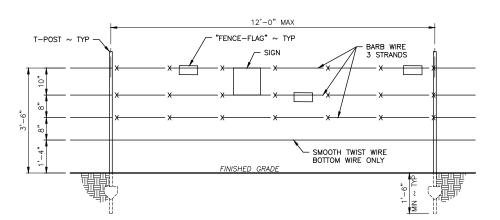


CORNER BRACE (ISOMETRIC)
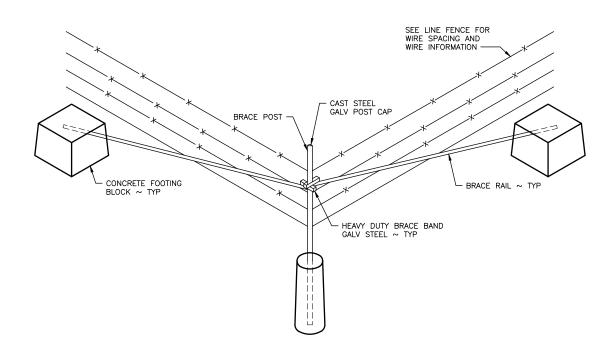
## **GENERAL NOTES:**

- SMOOTH TWIST WIRE SHALL BE 12 1/2 GAUGE, BARBLESS, WITH CLASS 3 GALVANIZING.
- 2. BARB WIRE SHALL BE 12 1/2 GAUGE WITH 4 POINT BARBS SPACED AT 5 INCHES WITH CLASS 3 GALVANIZING.
- 3. ALL VERTICAL STEEL BRACE AND HINGE POSTS SHALL HAVE A GALVANIZED METAL POST CAP.
- 4. IF DEPTH CANNOT BE REACHED DUE TO GROUND CONDITION USE ALTERNATE METHOD APPROVED BY ENGINEER.

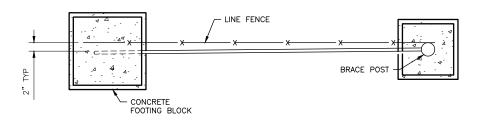

## PLAN

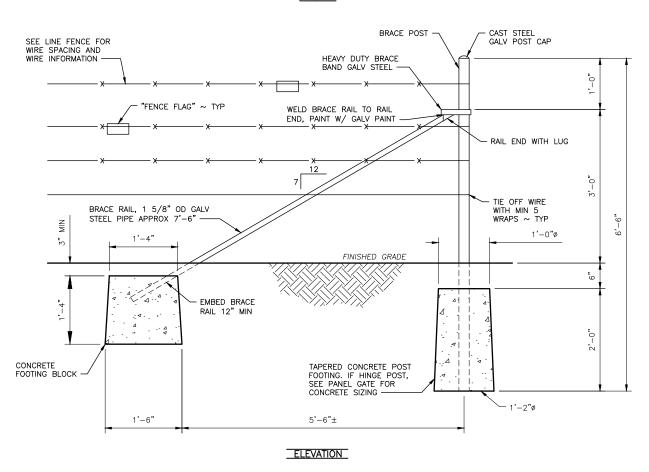

# END OR GATE BRACE DETAIL SCALE: 1/2" = 1'-0"

WASHINGTON DEPARTMENT OF FISH & WILDLIFE

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CHIEF ENGINEER DATE: PROGRAM DATE:				DRAWN BY R. SANTIAGO DATE 8/30/2024		

MIMA ACCESS & PARKING


LINE FENCE, CORNER BRACE &


GATE BRACE DETAILS


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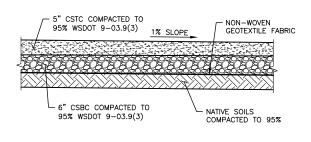
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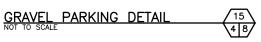
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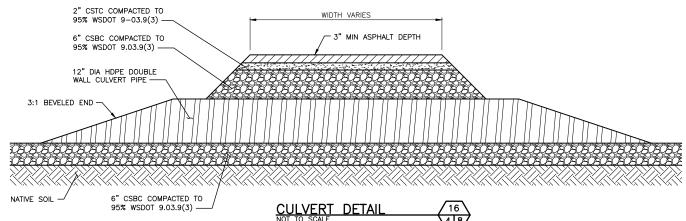







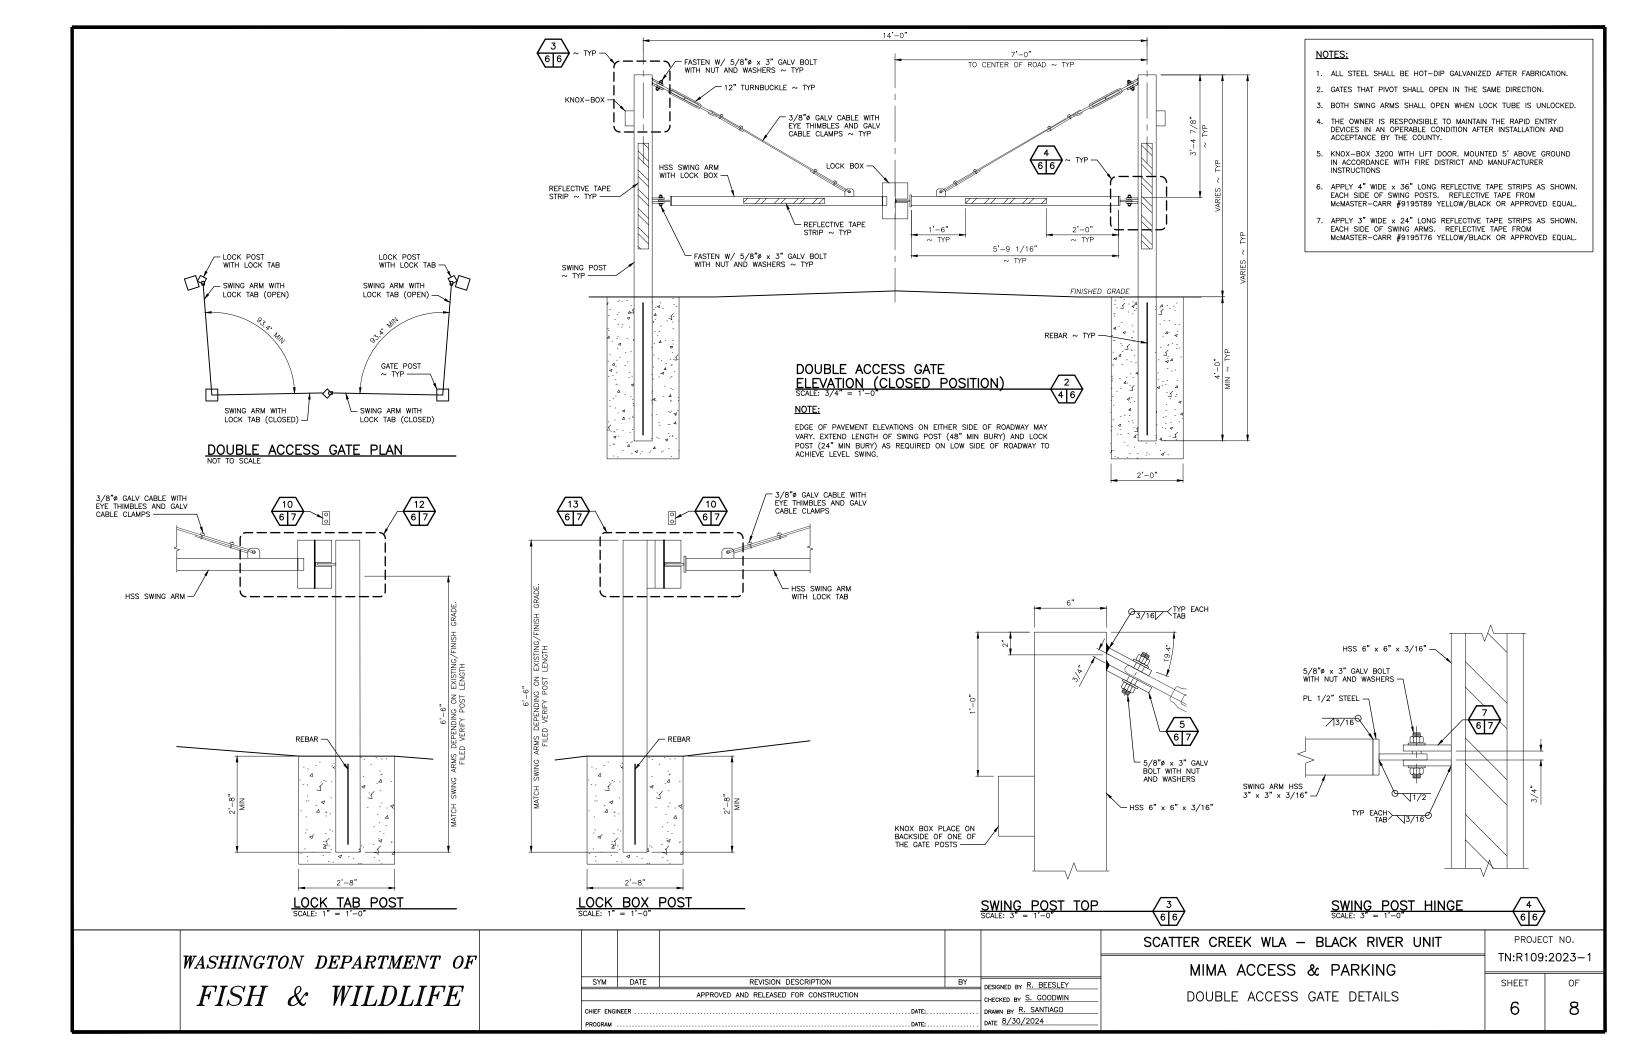

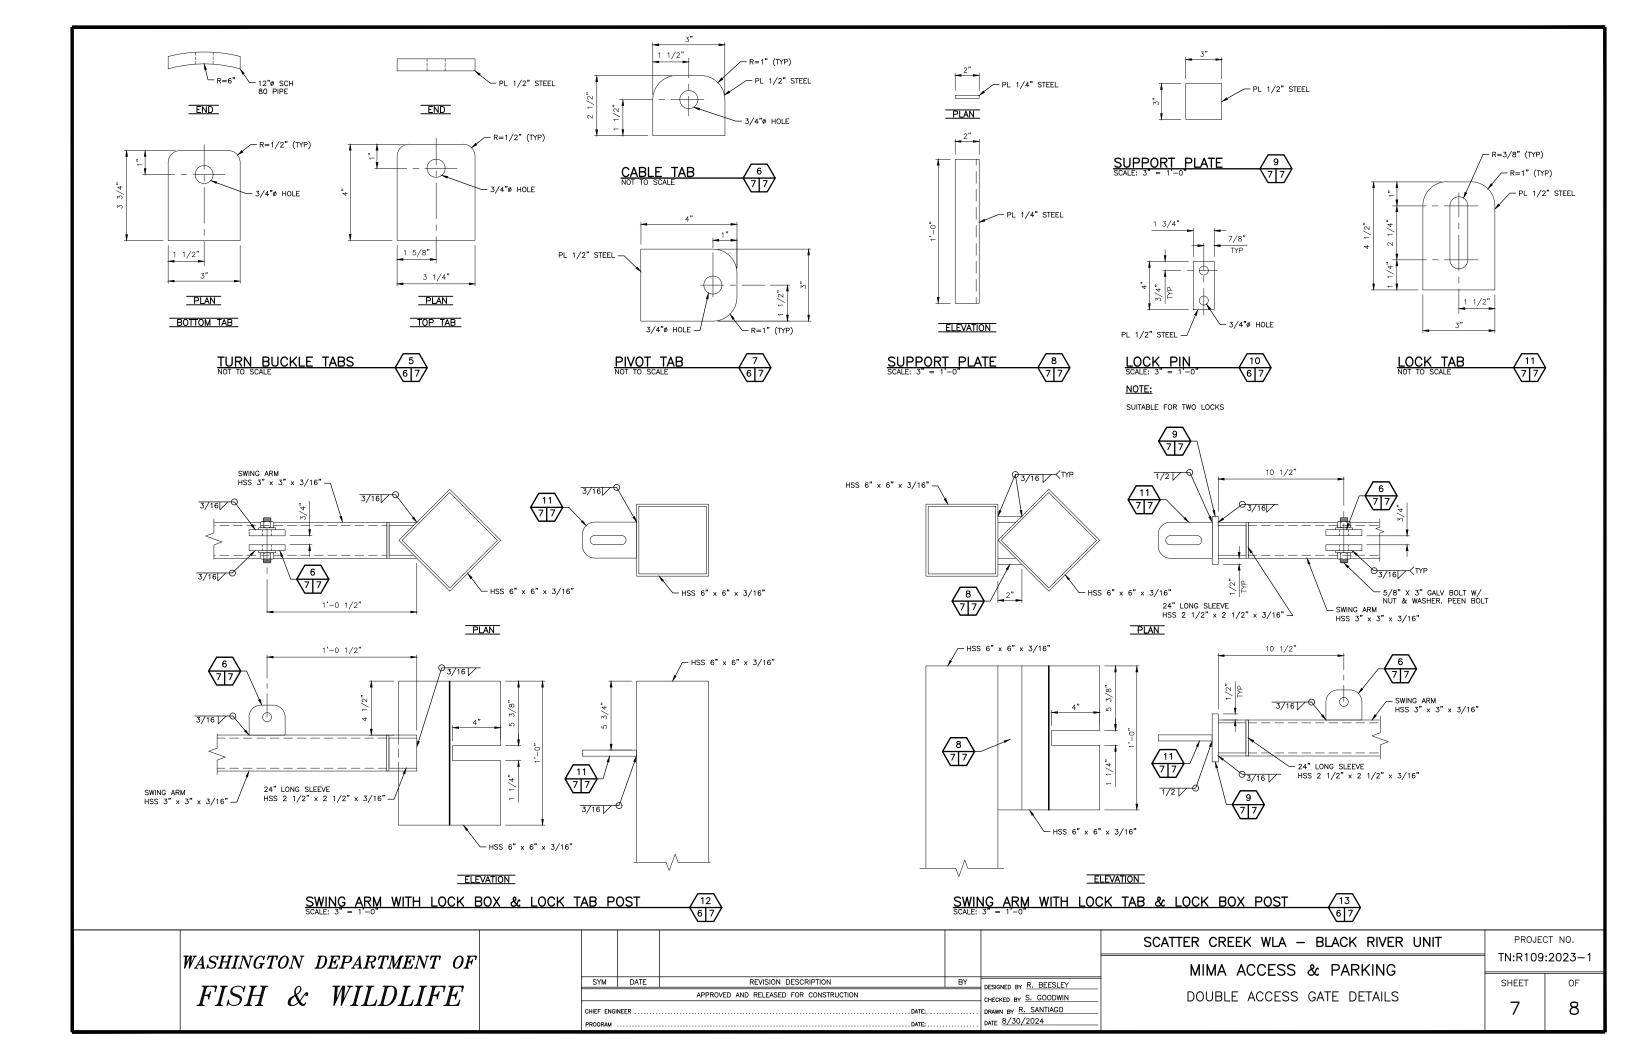

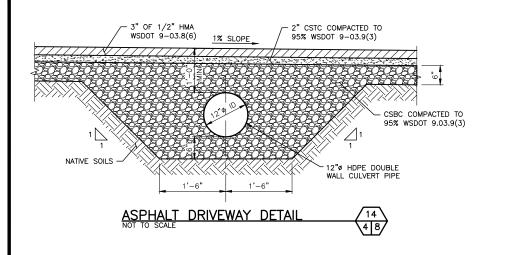

## METAL FLASHING W/ DRIP EDGE ALL EDGES — — 2x6 RIDGE 2x4 RAFTER @ 24" OC 2x6 --5/8" DIA x7" LONG MB 5/8" DIA x10" LÓNG LB — 3/4" ACX PLYWOOD W/ PLEXIGLASS. COVER BOTH SIDES -45° BEVEL -5/8" DIA x12" LONG MB LONG LB -6x6 -5/8" DIA x12" LONG MB -- ANGLE BRACKET

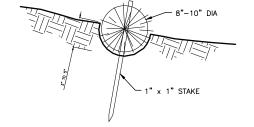


# STRAW WATTLE DETAIL

### **INSTALLATION NOTES:**

- 1. PREPARE THE SLOPE BEFORE THE WATTLING PROCEDURE IS STARTED.
- 2. SMOOTH SHALLOW GULLIES AS WORK PROGRESSES.
- 3. DIG SMALL TRENCHES ACROSS THE SLOPE ON CONTOUR, TO PLACE ROLLS IN. THE TRENCH SHOULD BE DEEP ENOUGH TO ACCOMMODATE HALF THE THICKNESS OF THE ROLL. WHEN THE SOIL IS LOOSE AND UNCOMPACTED, THE TRENCH SHOULD BE DEEP ENOUGH TO BURY THE ROLL 2/3 OF ITS THICKNESS BECAUSE THE GROUND WILL SETTLE.
- 4. ROLLS SHALL BE INSTALLED PERPENDICULAR TO WATER MOVEMENT, PARALLEL TO THE SLOPE CONTOUR.
- 5. BUILD TRENCHES AND INSTALL ROLLS FROM THE BOTTOM OF THE SLOPE AND WORK UP.
- 6. CONSTRUCT TRENCHES AT CONTOUR INTERVALS 3-12 FEET APART DEPENDING ON STEEPNESS OF SLOPE. THE STEEPER THE SLOPE, THE CLOSER TOGETHER THE TRENCHES. 1:1=10' 2:1=20' 3:1=30' 4:1=40'
- 7. LAY THE ROLL ALONG THE TRENCHES FITTING IT SNUGLY AGAINST THE SOIL. MAKE SURE NO GAPS EXIST BETWEEN THE SOIL AND THE STRAW WATTLE.
- 8. USE A STRAIGHT BAR TO DRIVE HOLES THROUGH THE WATTLE AND INTO THE SOIL FOR THE WILLOW OR WOODEN STAKES.
- 9. DRIVE THE STAKE THROUGH PREPARED HOLE INTO SOIL. LEAVE ONLY 1 OR 2 INCHES OF STAKE EXPOSED ABOVE ROLL.
- 10. IF USING WILLOW STAKES REFER TO LIVE STAKING BEST MANAGEMENT PRACTICES.
- 11. INSTALL STAKES AT LEAST EVERY 4 FEET APART THROUGH THE WATTLE. ADDITIONAL STAKES MAY BE DRIVEN ON THE DOWNSLOPE SIDE OF THE TRENCHES ON HIGHLY EROSIVE OR VERY STEEP SLOPES.
- 12. INSPECT THE STRAW ROLLS AND THE SLOPES AFTER SIGNIFICANT STORMS. MAKE SURE THE ROLLS ARE IN CONTACT WITH THE SOIL.
- 13. REPAIR ANY RILLS OR GULLIES PROMPTLY.
- 14. RESEED OR REPLANT VEGETATION IF NECESSARY UNTIL SLOPES ARE STABILIZED.

- CULVERT BOTTOM SHALL MATCH EXISTING DITCH/SWALE FLOWLINE. THIS MAY REQUIRE RE-GRADING OF THE DITCH/SWALE.
- 2. CULVERT SIZE SHALL MATCH THE DIAMETER OF THE CULVERT IMMEDIATELY UPSTREAM OR DOWNSTREAM, WHICHEVER IS LARGER.
- 3. PREFERRED CULVERT MATERIAL IS PLASTIC, BUT ALTERNATIVE MATERIAL WILL BE CONSIDERED ON A CASE BY CASE BASIS.
- 4. ZINC COATED METAL PIPE IS NOT AN ALLOWED ALTERNATIVE CULVERT MATERIAL
- 5. BEVELED CULVERT ENDS SHALL BE PLASTIC.

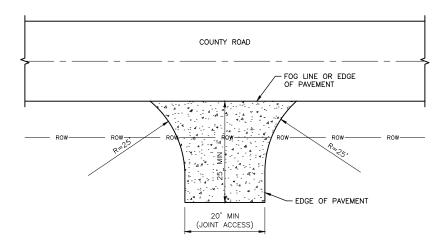

# COUNTY ROAD ACCESS — TYPE B

- 1. ALL APPROACHES SHALL BE INSTALLED WITH A STRUCTURAL CROSS SECTION THAT MATCHES THE SECTION OF THE CONNECTING DRIVEWAY/ROAD. GRAVEL DRIVEWAY/ROAD APPROACHES SHALL BE PAVED (2" MIN ASPHALT, 6" MIN
- 2. ALL APPROACHES ARE SYMMETRIC ABOUT CENTERLINE UNLESS OTHERWISE NOTED.
- WHERE LARGER TRUCK TURNING MOVEMENTS ARE ENCOUNTERED, LARGER RETURN RADII AND RIGHT TURN TAPERS MAY BE REQUIRED. RADIUS AND TAPERS SHALL BE DETERMINED BY THE COUNTY ENGINEER.
- 4. WHERE REQUIRED, CULVERTS SHALL BE IN ACCORDANCE WITH APPENDIX 7-B.

WASHINGTON DEPARTMENT OF FISH & WILDLIFE

KIOSK SIGNBOARD

2. ALL PLYWOOD SHALL BE ACX.

ALL 6x6 LUMBER ROUGH CUT.

1. ALL BOLTS, NUTS, AND HARDWARE SHALL BE GALVANIZED.

ALL LUMBER DOUGLAS FIR, CONST GRADE. SHALL BE PRESSURE TREATED.

RE-SAWN SHAKES OVER 15# FELT OVER 1/2" CDX PLYWOOD.

5. ALL OTHER LUMBER, S4S, ROOF SHALL CONSIST OF

24" DIA CONC

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SCATTER CREEK WLA - BLACK RIVER UNIT MIMA ACCESS & PARKING

> CULVERT, KIOSK, STRAW WATTLE & COUNTY ROAD ACCESS DETAILS

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